

"OZONE SI_LEC OPT B" BIM Server: BIM-Server.local - BIM Server 20/171109_5-9 OZONE SI Cronulla/OZONE SI_LEC OPT B	
vic lake architect	H 6/11/18 Drawing amended to comply with Ozone St setback following meeting with Council dated 5/11/18
vic lake architect	E 30/10/18 ISSUED TO L&E COURT
0400 284 587	D 30/8/18 REVISED ISSUE
viclakearchitect.com.au nominated architect: Vic Lake NSW reg. 4475	C 6/8/18 PRELIMINARY FOR COMMENT/FEEDBACK FROM COUNCIL D DATE DESCRIPTION
	is still section

PROJECT: PRO.

RESIDENTIAL FLAT BUILDING 171


PROJECT ADDRESS: CUE

5-9 OZONE ST CRONULLA 2230 REB

DRAWING NAME:

PROPOSED SHADOWS - WINTER SOLSTICE

PROJECT NUMBER:
171120
CUENT:
REBEL PROPERTY GROUP
LEDA HOLDINGS

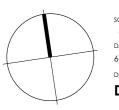


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@ A3


DATE:
6/11/18

DRAWING NUMBER / REV:

DA06.10 H



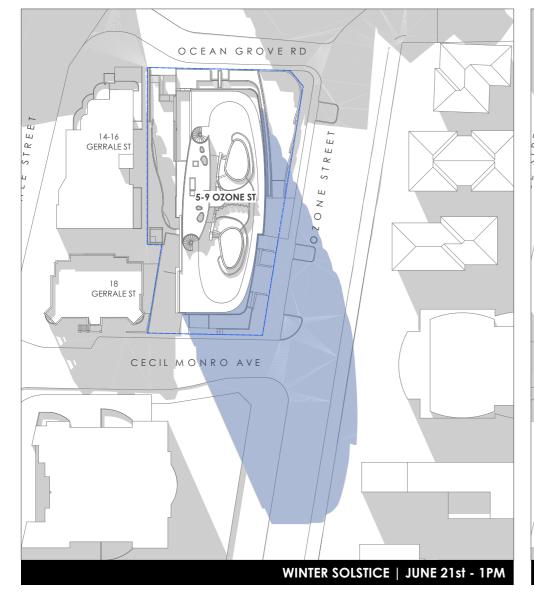


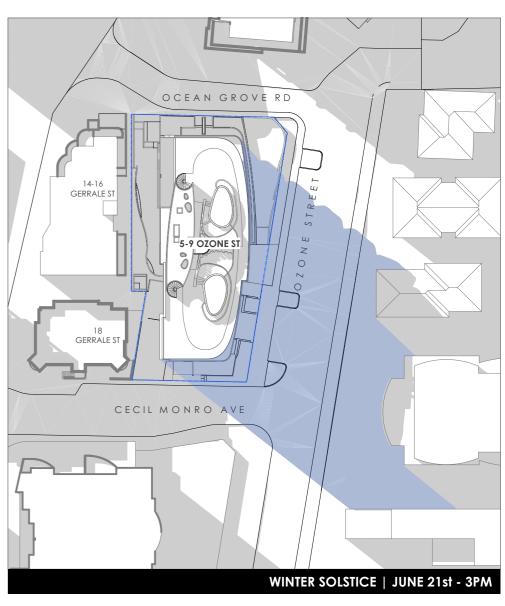

"OZONE St_LEC OPT B" BIM Server; BIM-ServerJocal - BIM Server 20/171109_5-9 OZONE St Cronulla/OZONE St_LEC OPT B	H 6/11/18 Drawing amended to comply with Ozone St setback following meeting wi
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5-9 OZONE ST CRONULLA 2230
DRAWING NAME:

PROJECT NUMBER:
171120
CLIENT:
REBEL PROPERTY GROUP
LEDA HOLDINGS

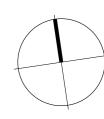

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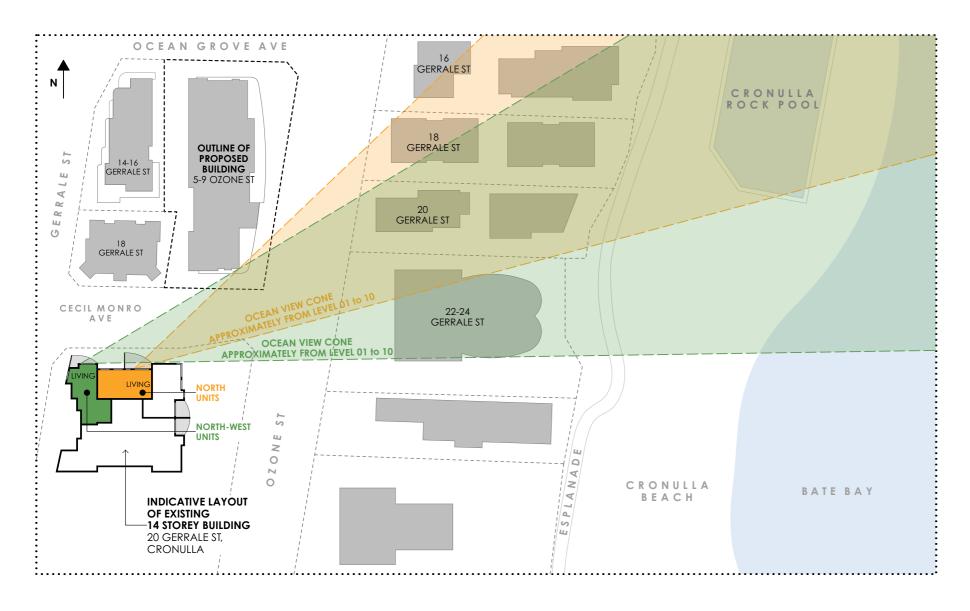
DATE:
6/11/18

DRAWING NUMBER / REV:

DA06.10.02 H

PROPOSED SHADOWS - WINTER SOLSTICE

20 GERRALE ST, CRONULLA "CECIL" - VIEW ANALYSIS APPROX. FROM LEV 01 to 10







VIEW ANALYSIS FROM 20 GERRALE ST, CRONULLA Sheet 1

Photos courtesy of Realestate.com.au

NOT TO SCALE @ A3

SCALE:

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VIC lake architect

0400 284 587

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nominated architect: Vic Lake NSW reg. 4475

PROJECT:

RESIDENTIAL FLAT BUILDING
PROJECT ADDRESS:
5-9 OZONE ST CRONULLA 2230
DRAWING NAME:


PROJECT NUMBER:
171120
CLIENT:
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LEDA HOLDINGS

ERTY GROUP NGS

DA06.21 H

6/11/18

20 GERRALE ST, CRONULLA "CECIL" - VIEW ANALYSIS APPROX. FROM LEV 11 to 13

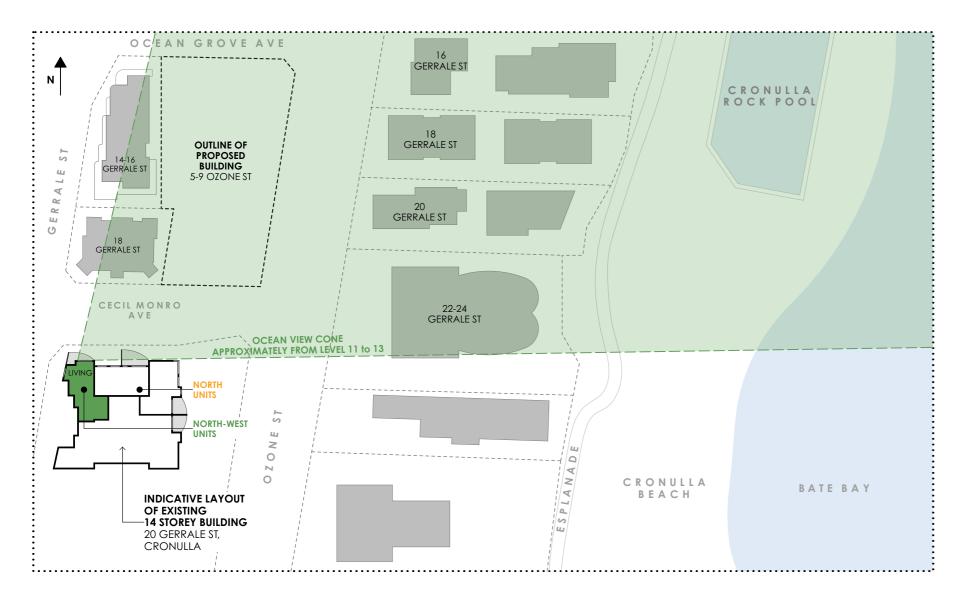



VIC Lake architect

Vic lake architect vic Lake NSW reg. 4475

A 20/3/18 ISSUE FOR COUNCIL

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RESIDENTIAL FLAT BUILDING
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171120

PROJECT ADDRESS:
5-9 OZONE ST CRONULLA 2230

REBEL PROPERTY GROUP

LEDA HOLDINGS

DRAWING NAME:

VIEW ANALYSIS FROM 20 GERRALE ST, CRONULLA Sheet 2


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DATE:
6/11/18
DRAWING NUMBER / REV:


DA06.22 H


1. BUILDING FOOTPRINT

2. MAXIMISING OCEAN VIEWS

3. ROTATION FOR IMPROVED SOLAR ACCESS REFER TO DA06.44 FOR SOLAR ACCESS TO COS

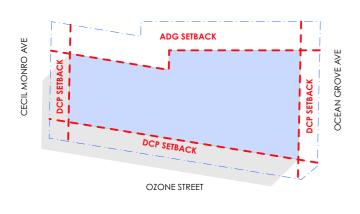

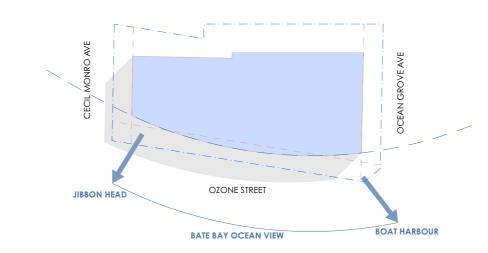


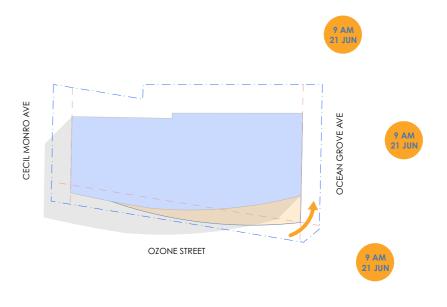

4. RESPONDING TO STREET CORNERS AND STREET SETBACKS

CURVED BUILDING FORM OZONE STREET TRANSITIONAL CURVED BUILDING FORM

5. VIEW ANALYSIS REFER TO DA06.42 AND DA06.43 FOR EXISTING

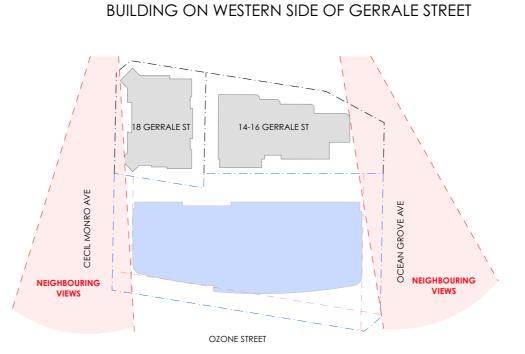

6. LANDSCAPING CONNECTION



vic lake	architect
	0400 284 587

viclakearchitect.com.au

н	7/11/18	Drawing amended to comply with Ozone St setback following meeting with Council dated 5/11/18
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ID	DATE	DESCRIPTION

PROJECT: RESIDENTIAL FLAT BUILDING PROJECT ADDRESS:

5-9 OZONE ST CRONULLA 2230 BUILDING FORM DEVELOPMENT DIAGRAM

171120

PROJECT NUMBER

REBEL PROPERTY GROUP LEDA HOLDINGS

DA06.39 H

SCALE:


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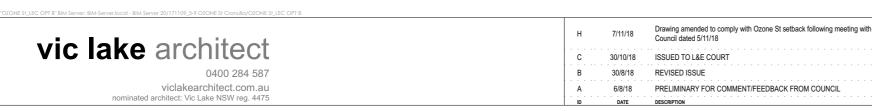
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7/11/18

VIEWS FROM 'THE BELGRAVE' 31-33 GERRALE ST

VIEWS FROM 'BREEZE' 19 GERRALE ST



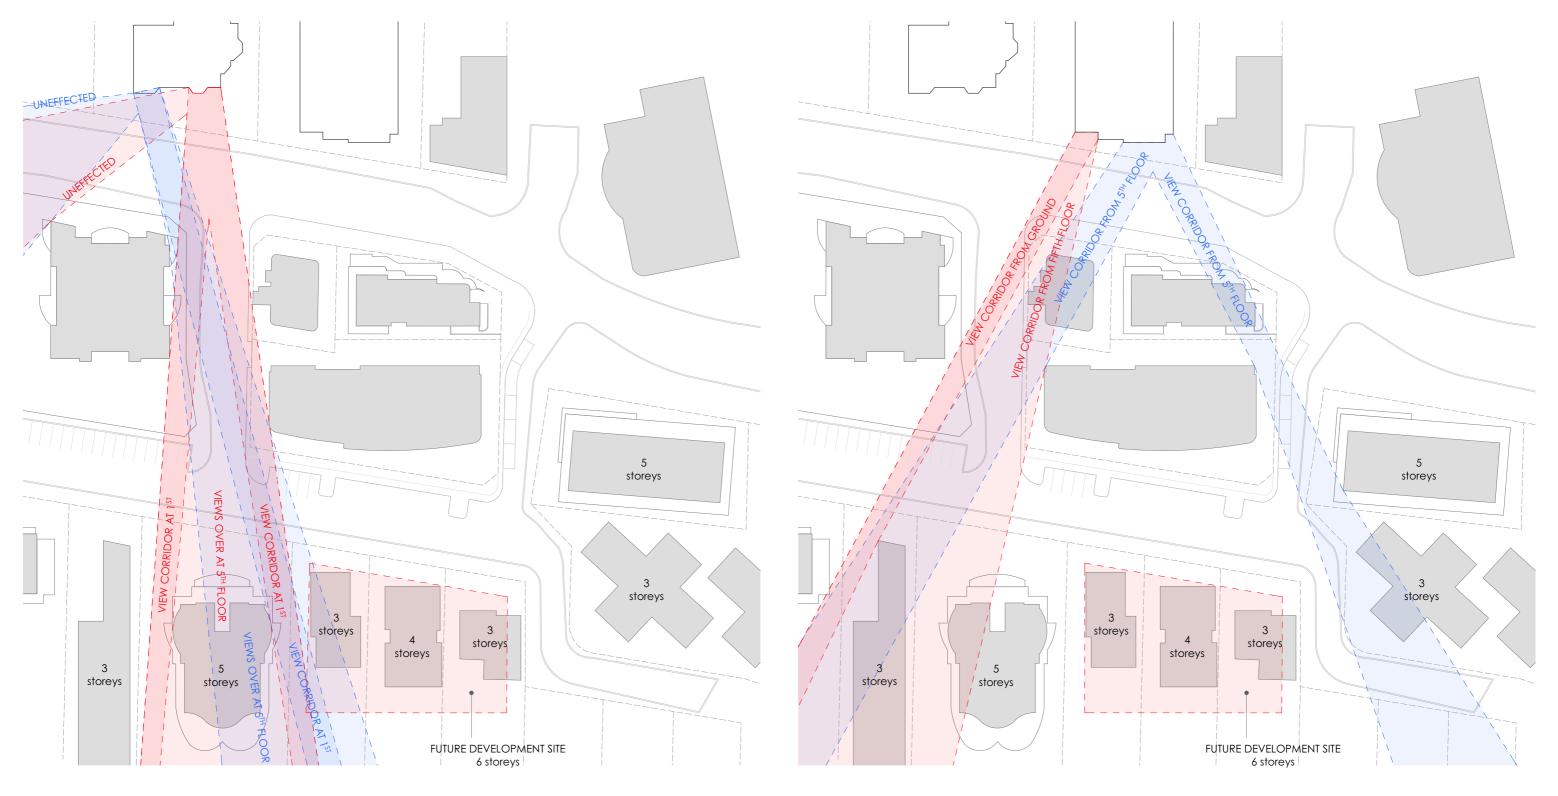

PROJECT:
RESIDENTIAL FLAT BUILDING
PROJECT ADDRESS:
5-9 OZONE ST CRONULLA 2230
DRAWING NAME:
PROPOSED VIEWS ANALYSIS

171120 CLIENT: REBEL PROPERTY GROUP LEDA HOLDINGS

PROJECT NUMBER:


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DATE:

7/11/18

DA06.41 H




vic lake architect

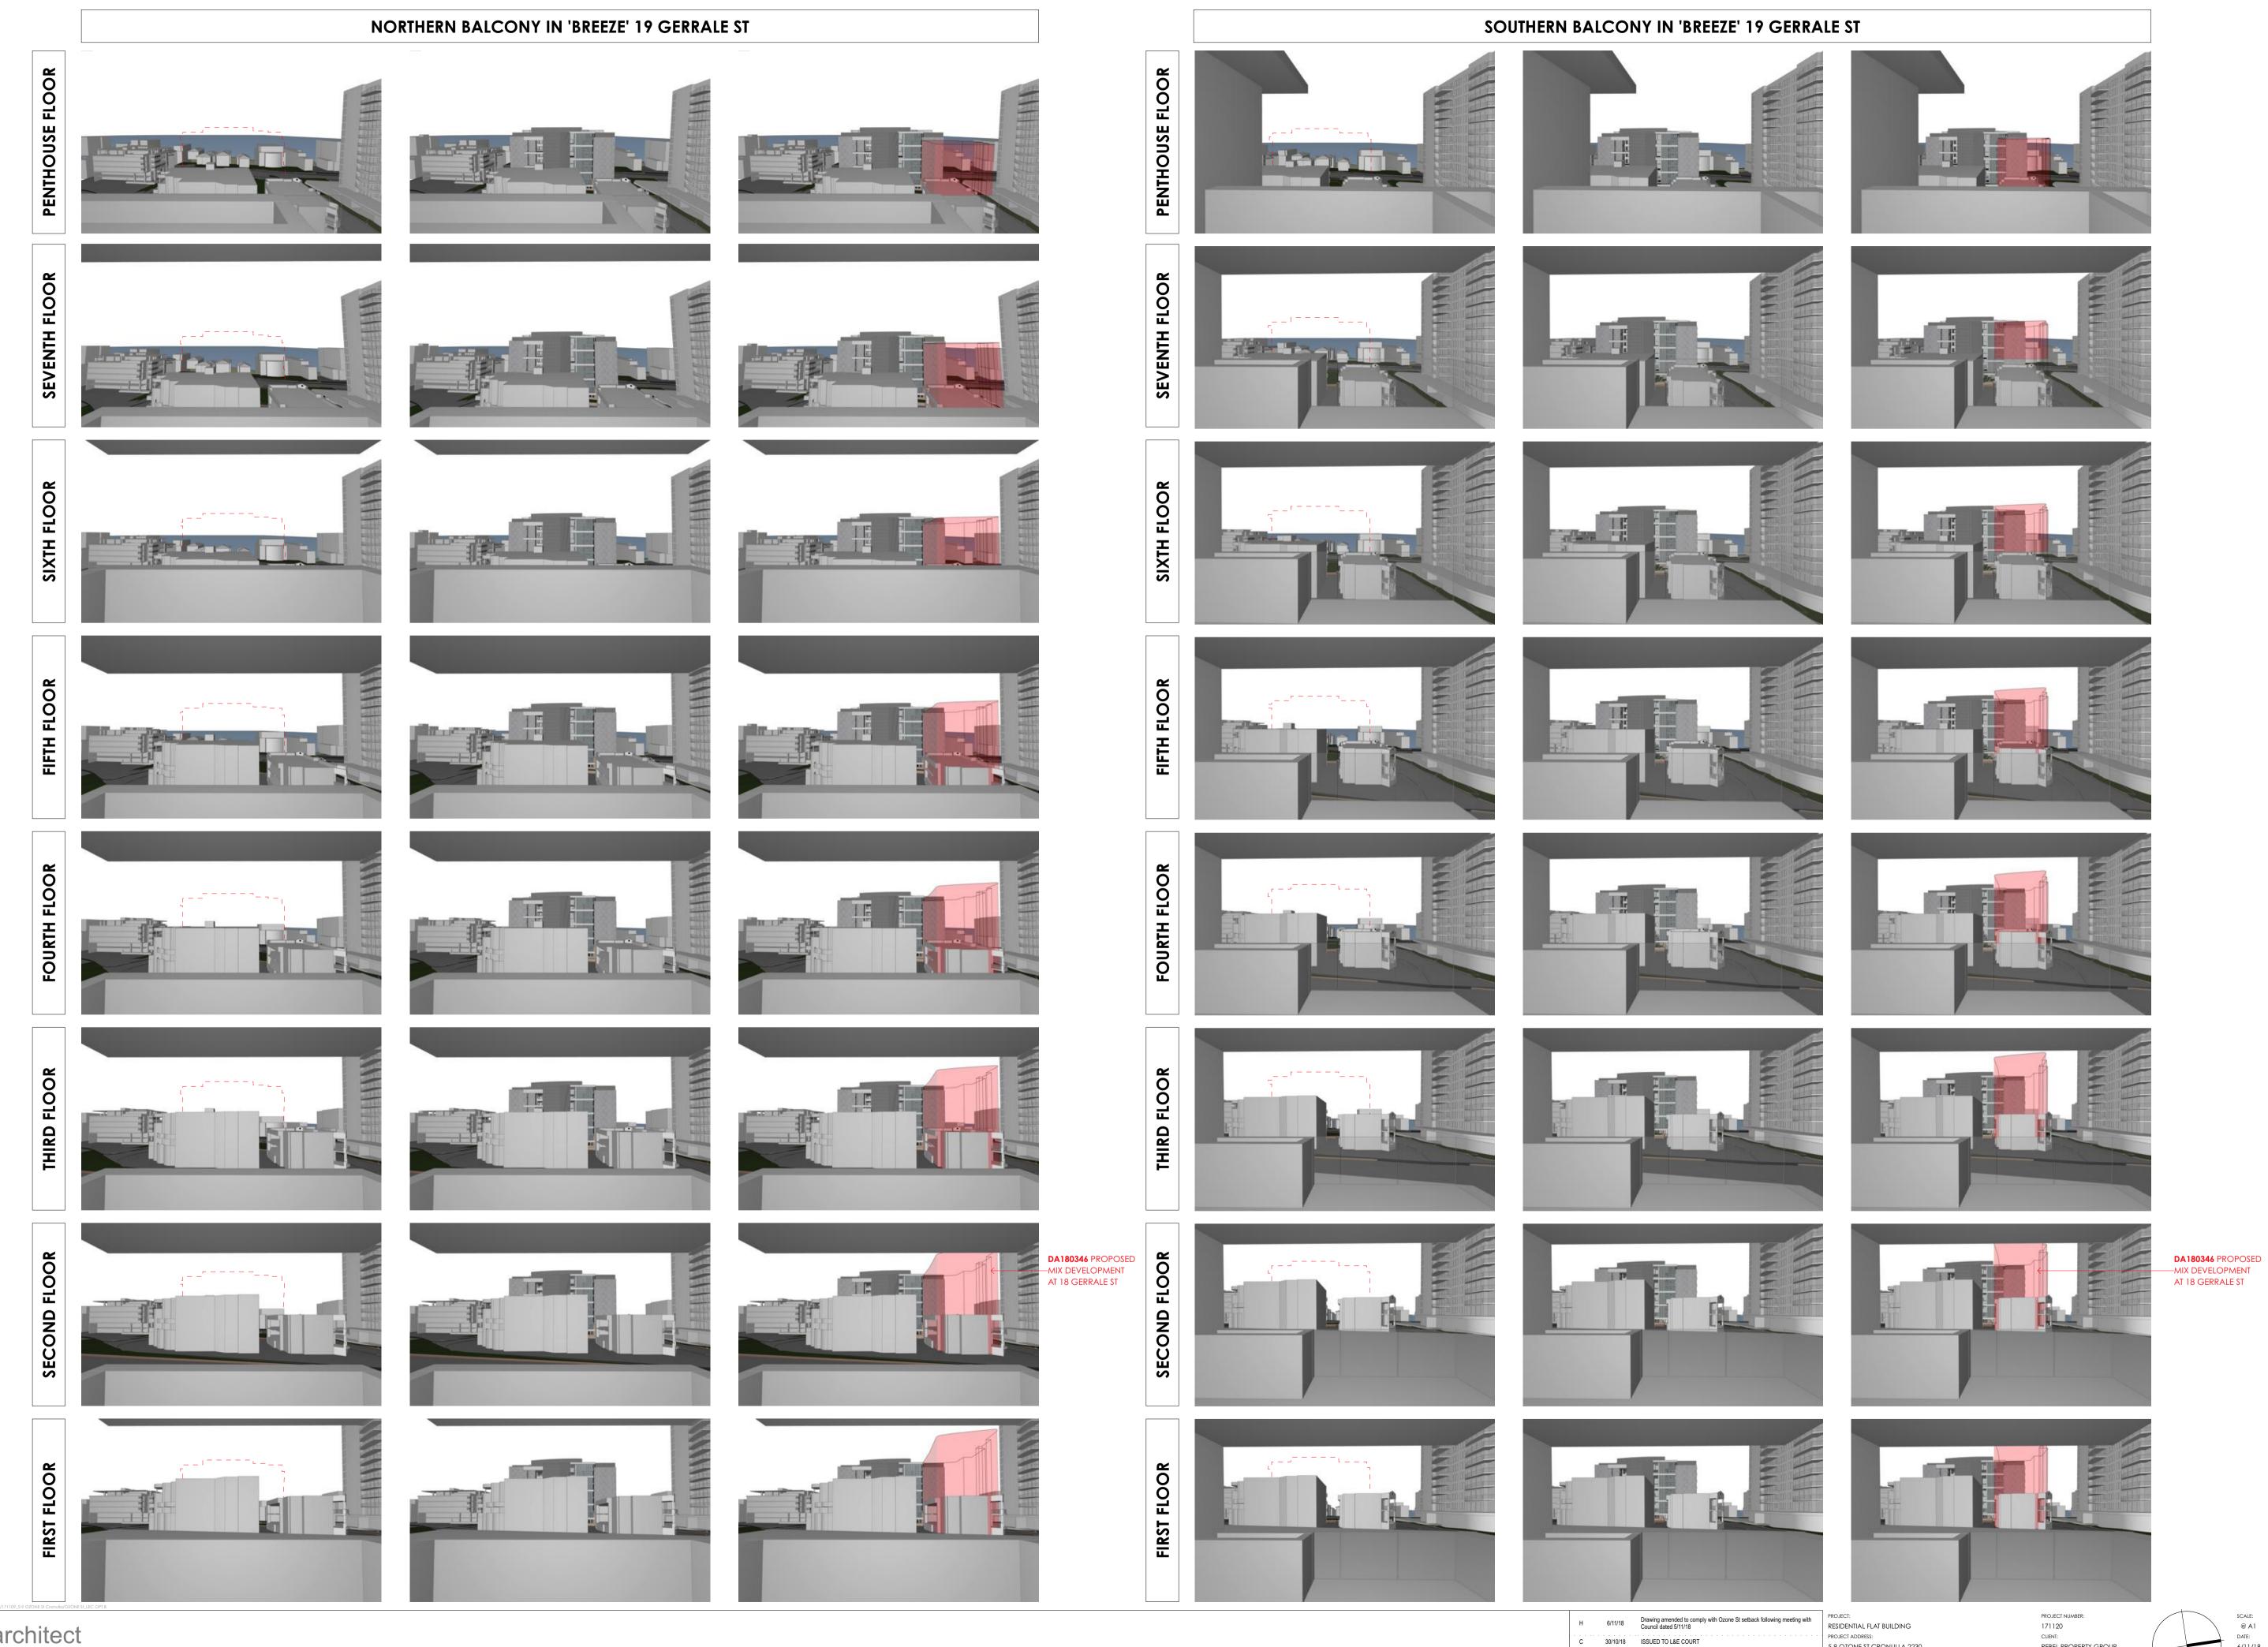B 30/8/18 REVISED ISSUE A 6/8/18 PRELIMINARY FOR COMMENT/FEEDBACK FROM COUNCIL 5-9 OZONE ST CRONULLA 2230

REBEL PROPERTY GROUP LEDA HOLDINGS

SCALE: @ A1 6/11/18 **DA06.42** H


Page 116 of 138

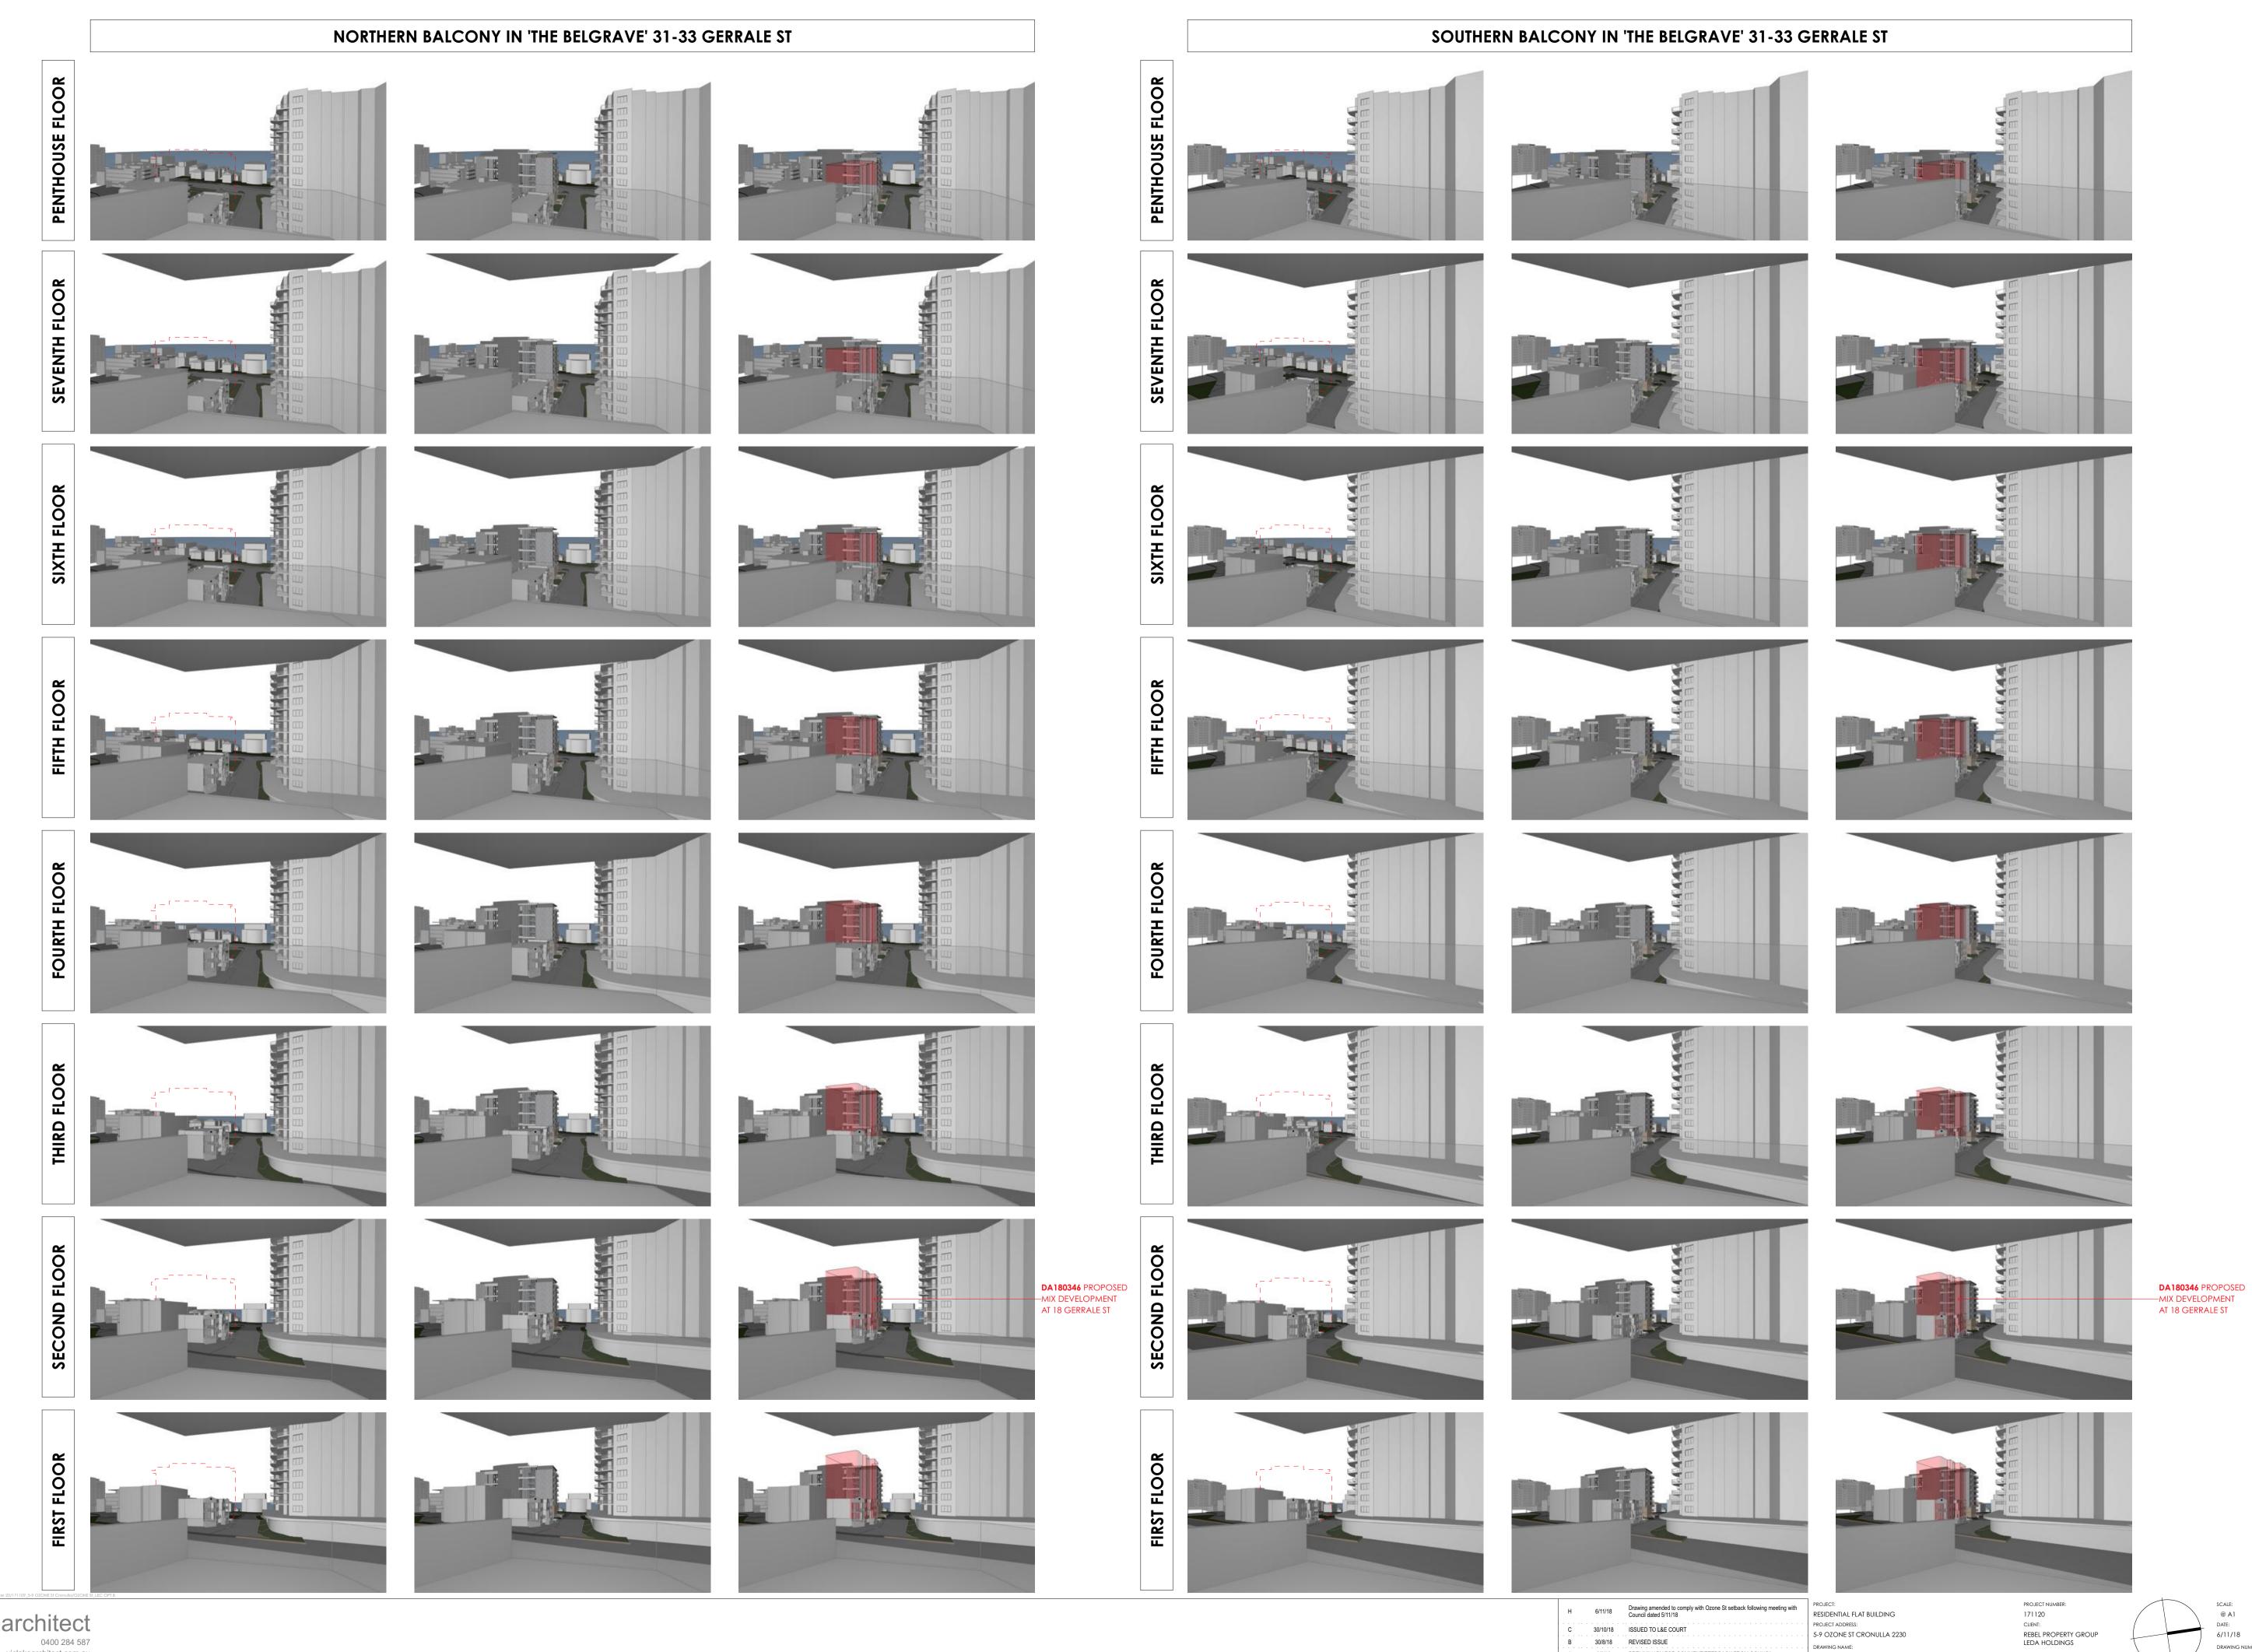



vic lake architect


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Page 117 of 138



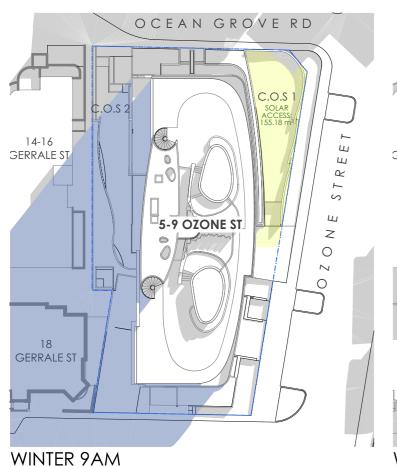


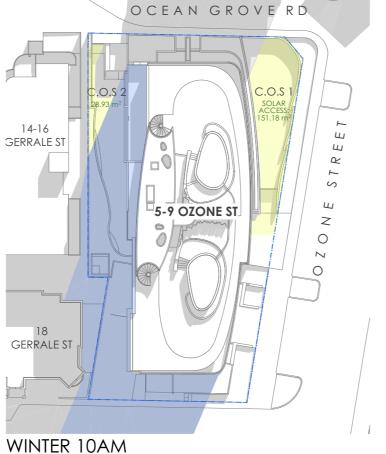


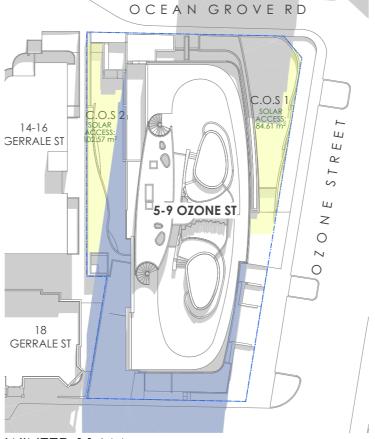

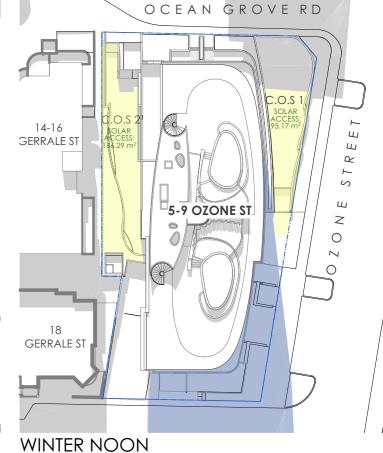WINTER 11AM

WINTER 3PM

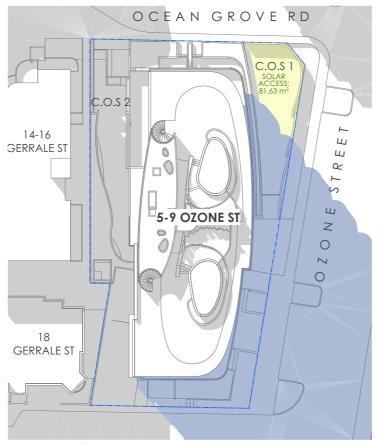

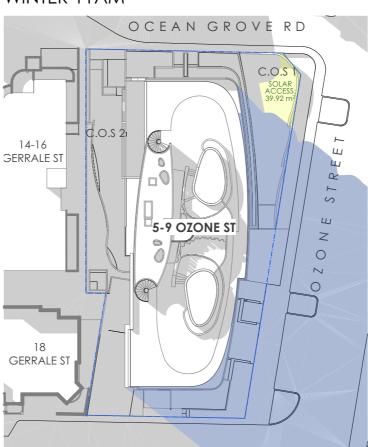

SEPP 65 APARTMENT DESIGN GUIDEObjective 3D-1

.....

Developments achieve a minimum of 50% direct sunlight to the principal usable part of the communal open space for a minimum of 2 hours between 9 am and 3 pm on 21 June (mid winter)

TIME	COS 1 SOLAR ACCESS		
9 AM	155.18 m ²	93 %	
10 AM	151.18 m ²	90 %	
11 AM	84.61 m ²	51 %	
12 AM	95.17 m ²	57 %	
1 PM	83.57 m ²	50 %	
2 PM	81.63 m ²	49 %	
3 PM	39.92 m ²	24 %	

COS 2 SOLAR ACCESS (235 m²)		
0 m ²	0 %	
28.93 m ²	12 %	
102.57 m ²	44 %	
166.29 m ²	71 %	
37.67 m ²	16%	
0 m ²	0 %	
0 m ²	0 %	

WINTER 2PM


vic lake architect
0400 284 587
viclakearchitect.com.au

WINTER 1PM

н	7/11/18	Drawing amended to comply with Ozone St setback following meeting with Council dated 5/11/18
D	30/10/18	ISSUED TO L&E COURT
С	7/10/18	REVISION 2
В	30/8/18	REVISED ISSUE
ID	DATE	DESCRIPTION

PROJECT:
RESIDENTIAL FLAT BUILDING
PROJECT ADDRESS:
5-9 OZONE ST CRONULLA 2230
DRAWING NAME:
COS SOLAR ACCESS

PROJECT NUMBER: 171120 CLIENT: REBEL PROPERTY GROUP LEDA HOLDINGS

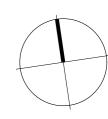

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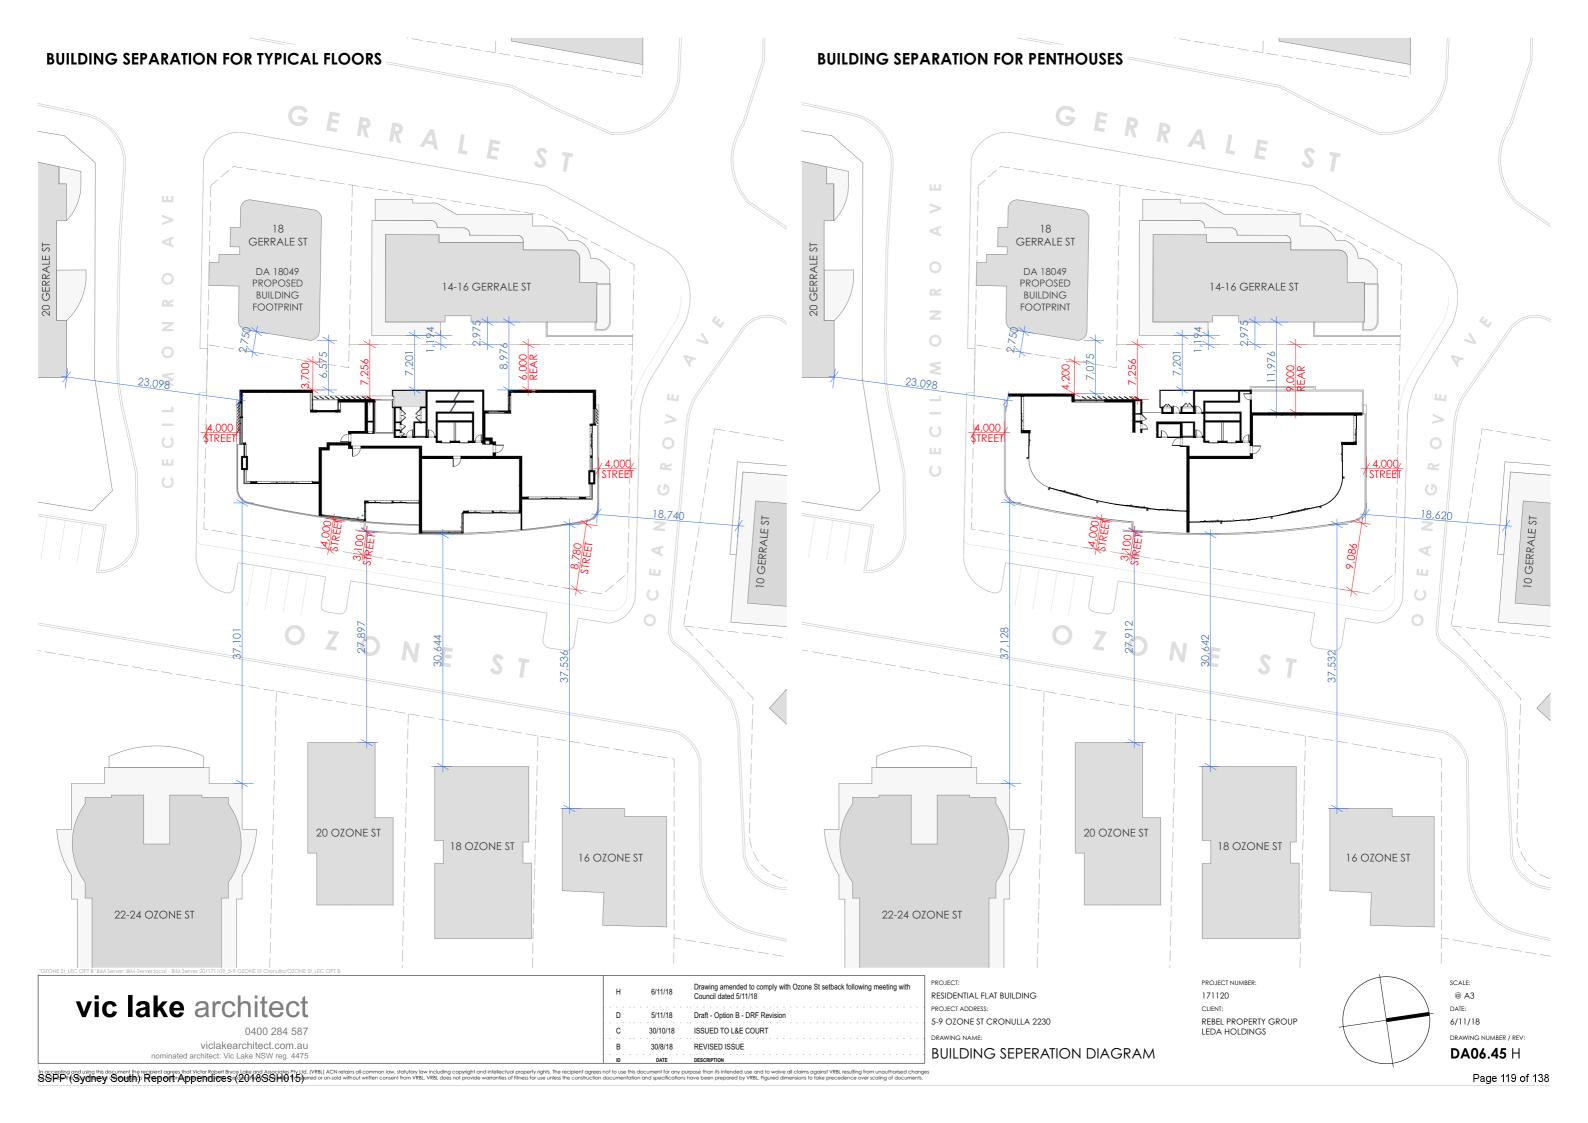
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DATE:

7/11/18

DRAWING NUM

DA06.44 H



_5-9 OZONE ST, CRONULLA PROPOSED DEVELOPMENT 20 GERRALE ST, CRONULLA _"CECIL APARTMENTS" EXISTING 14 STOREY RESIDENTIALBUILDING

_5-9 OZONE ST, CRONULLA PROPOSED DEVELOPMENT 20 GERRALE ST, CRONULLA __"CECIL APARTMENTS"

EXISTING 14 STOREY
RESIDENTIALBUILDING _5-9 OZONE ST, CRONULLA PROPOSED DEVELOPMENT 20 GERRALE ST, CRONULLA "CECIL APARTMENTS"
EXISTING 14 STOREY
RESIDENTIALBUILDING

20 GERRALE ST, CRONULLA _"CECIL APARTMENTS"
EXISTING 14 STOREY
RESIDENTIALBUILDING







_5-9 OZONE ST, CRONULLA
PROPOSED DEVELOPMENT

21 JUNE | 9AM 21 JUNE | 10AM 21 JUNE | 11AM 21 JUNE | 12PM

vic lake architect

viclakearchitect.com.au nated architect: Vic Lake NSW reg. 4475

Drawing amended to comply with Ozone St setback following meeting with Council dated 5/11/18 ISSUED TO L&E COURT REVISION 2 7/10/18 REVISED ISSUE 30/8/18 DATE DESCRIPTION

PROJECT: RESIDENTIAL FLAT BUILDING PROJECT ADDRESS: 5-9 OZONE ST CRONULLA 2230


SOLAR STUDY ON CECIL APARTMENTS

PROJECT NUMBER: 171120 CLIENT: REBEL PROPERTY GROUP LEDA HOLDINGS

SCALE: NOT TO SCALE @ A3 DATE: 7/11/18


DRAWING NUMBER / REV:

DA06.46 H

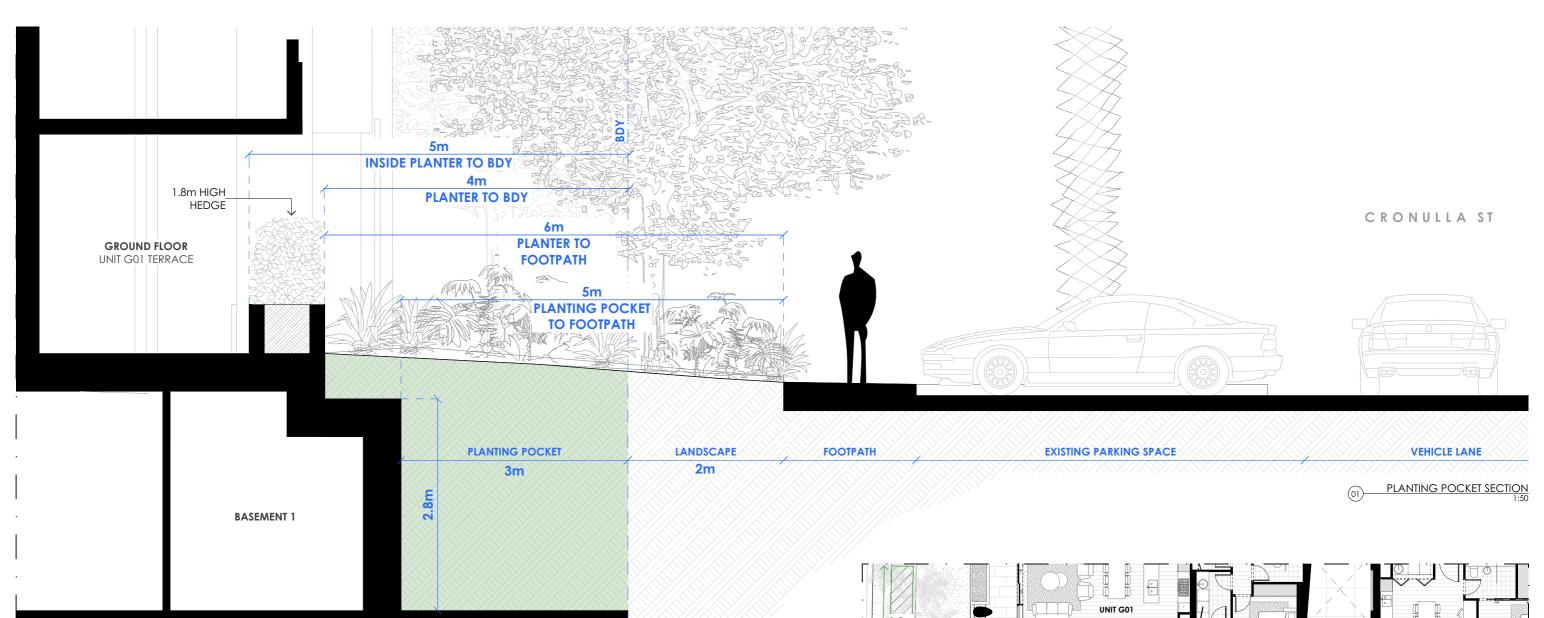

ADG MINIMUM SOIL STANDARD REQUIREMENT

Plant type	Definition	Soil valume	Soil depth	Soil area
Large trees	12-18m high, up to 16m crown spread at maturity	150m³	1,200mm	10m x 10m or equivalent
Medium trees	8-12m high, up to 8m crown spread at maturity	35m³	1,000mm	6m x 6m or equivalent
Small trees	6-8m high, up to 4m crown spread at maturity	9m³	800mm	3.5m x 3.5m or equivalent
Shrubs			500- 600 mm	
Ground cover			300-450mm	
Turf			200mm	

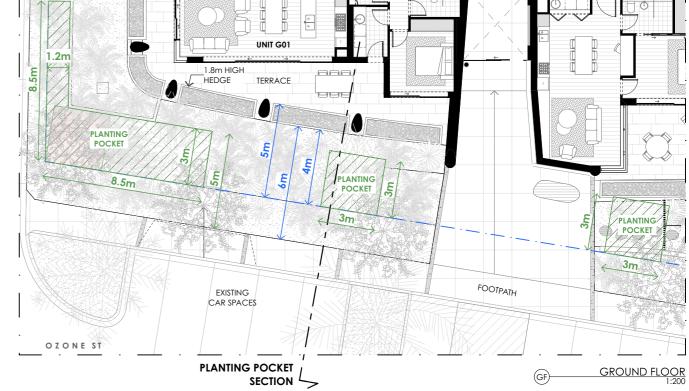

PROJECT NUMBER:

171120

vic lake architect

viclakearchitect.com.au

ISSUED TO L&E COURT 30/10/18 7/10/18 **REVISION 2**

PROJECT: RESIDENTIAL FLAT BUILDING PROJECT ADDRESS:

5-9 OZONE ST CRONULLA 2230

PLANTING POCKET

CLIENT: REBEL PROPERTY GROUP LEDA HOLDINGS

SCALE: 1:200, 1:50 @ A3 DATE: 7/11/18

DA06.48 H

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L13 Planting Palette and Design Precedent Images	14

CLIENTS:

REBEL

PROPERTY GROUP



LANDSCAPE ARCHITEC



Studio 25, 13-29 Nichols Street, Surry Hills, NSW 2010

P: (02) 9360 7771

PROJECT NO.	ISSUE	DATE	TYPE	DRAWN	REVIEWED BY
17-0679L	A	19/01/2018	LCP	LN	DV
17-0679L	В	25/01/2018	LCP	LN	DV
17-0679L	C	31/01/2018	LCP	LN	DV
17-0679L	D	08/02/2018	LCP	LN	DV
17-0679L	E	07/03/2018	LCP	LN	DV
17-0679L	F	19/03/2018	LCP	LN	DV
17-0679L	G	20/03/2018	LCP	LN	DV
17-0679L	H	03/08/2018	LCP	LN	DV
17-0679L	T	18/08/2018	LCP	LN	DV
17-0679L	1	27/08/2018	LCP	LN	DV
17-0679L	K	22/10/2018	LCP	LN	DV
17-0679L	L	31/10/2018	LCP	LN	DV
17-0679L	M	08/11/2018	LCP	LN	DV




01 Context & Landscape Intent





Site Context Plan MACRO - NTS

Site Context Plan MICRO - NTS

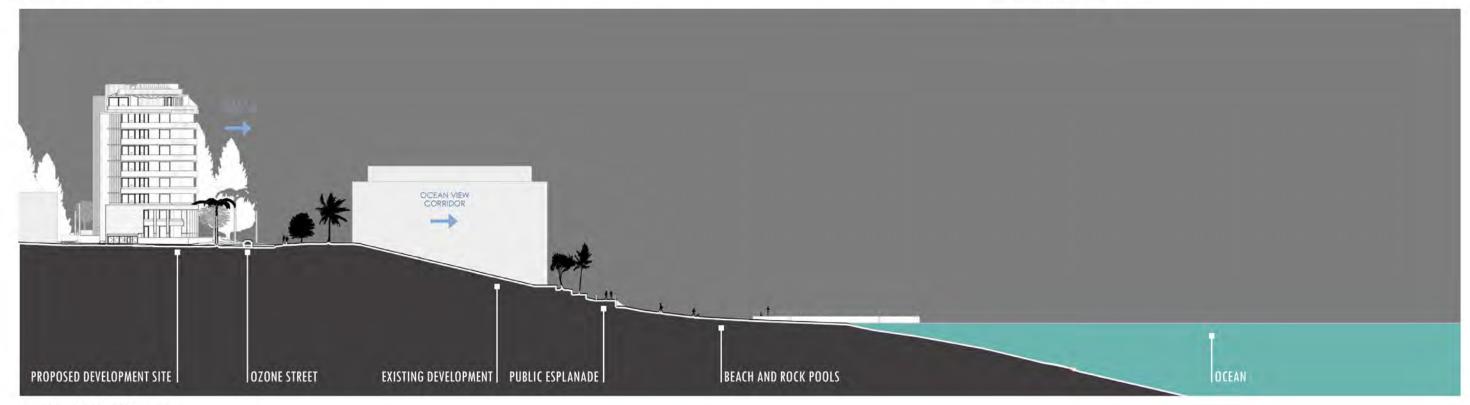

3

PUBLIC DOMAIN INTERFACE - NTS
[REF: VIC LAKE ARCHITECT DWG DA06.09]

habit8
Page 124 of 138




[REF: VIC LAKE ARCHITECT DWG DA06.08]



08/11/2018 | Revision M | 17-0679L | 5-9 Ozone Street, Cronulla, NSW Issue: Draft - Option B - DRF Revision

SSPP (Sydney South) Report Appendices (2018SSH015)

03 The Green Ribbon Link

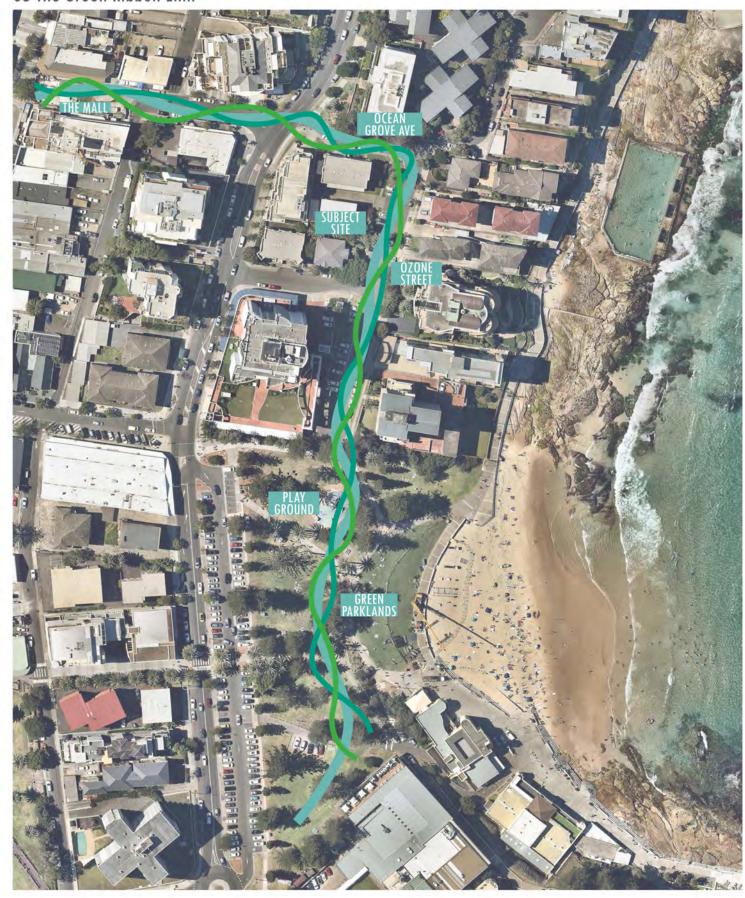

The 'Green Ribbon Link' is a connecting spine that runs from the Mall, along Ocean Grove Ave, connecting into Ozone Street where is flows between the sites boundary and down into the vibrant green beachside parklands.

04 Overall Landscape Character







The landscape strategy for 5 - 9 Ozone Street aims to work seamlessly with the The material palette is comprised of a succinct selection of architecture, to not only support its' function, but more so, to transform it into a vibrant residential community. A bespoke site wide planting strategy aims to respond to the sites context and ground the design into the greater Cronulla residential fabric. The proposed landscape palette focusses on creating a shared environment for the community. High end finishes have been paired with lush tropical planting to develop sophisticated and stylish spaces. The landscape will complement the architectural features, increasing the users' experience and maximising comfort through light and shade.

- Integrate the sites street frontages into the broader context and provide suitable buffer planting to aid acoustic and visual solutions for the neighbouring properties.
- Provide a landscape character that will not only integrate with the architectural built form but encourage the two to work seamlessly together and provide visual interest to key aspects of the site.
- Planting palette that is reflective of the local area climate and character.

robust and functional materials, suitable for residential use. The colour and finishes will complement the architectural palette ensuring a site wide cohesive aesthetic is achieved.

A feature pavement will assist legibility, signifying the building entries and feature nodes.

The streetscape design will conform to the relevant local authorities' landscape requirements, whilst responding appropriately to the character of the built form.

The opportunities for water infiltration will be maximised onsite through the direction of hard surfaces towards planted areas wherever possible.

The planting strategy aims to soften the built form, visually engage users, and provide comfort through the use of shade. The planting palette will consist of a mix of robust and low maintenance plant species, providing a variety of colour and texture.


By specifying a mix of native endemic and drought tolerant plant communities, the planting design will offer diversity in texture, form and colour, and support a tropical landscape character.

A mixture of lush columnar trees, rounded canopy trees, screening shrubs and groundcovers will provide a screen to side boundaries where appropriate space is available.

Plants species will be located relative to site conditions, allowing for cool breezes and providing suitable shade within the site. This strategy maximises the use of the spaces across the day and seasons.

All hard landscape elements, services, or unsightly infrastructure will be softened with planting as applicable.


LO6LANDSCAPE PLAN - GROUND LEVEL

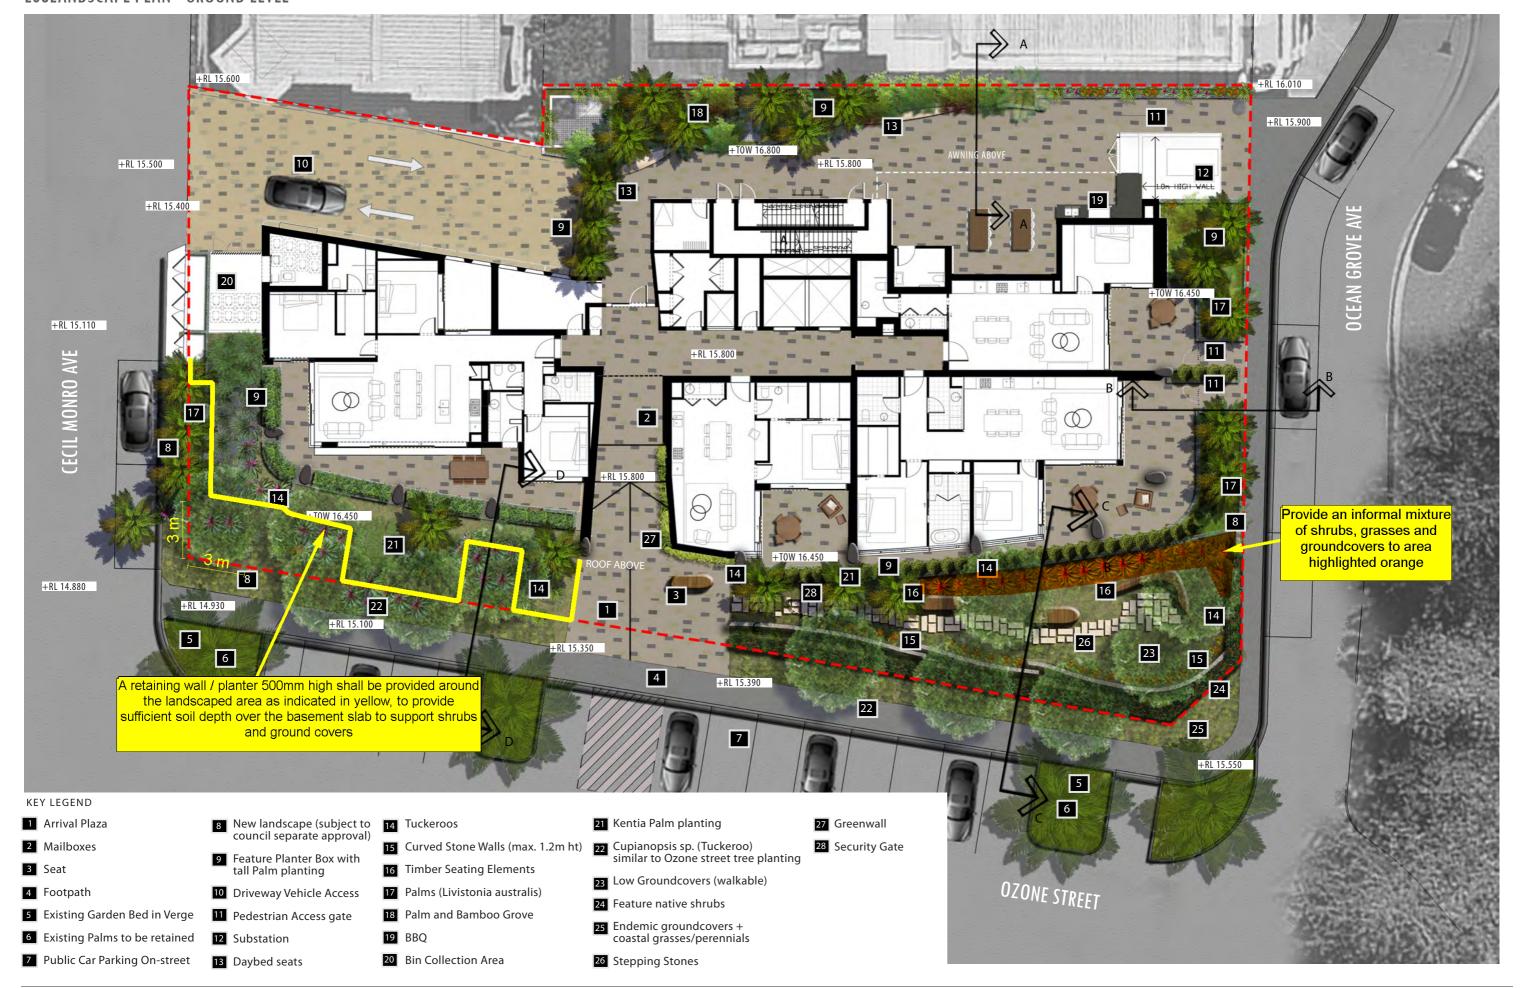


PLANTERS LEVEL 1,2,4 & 6 - DETAIL PLAN




PLANTERS LEVEL 1,3,5 & 7 - DETAIL PLAN

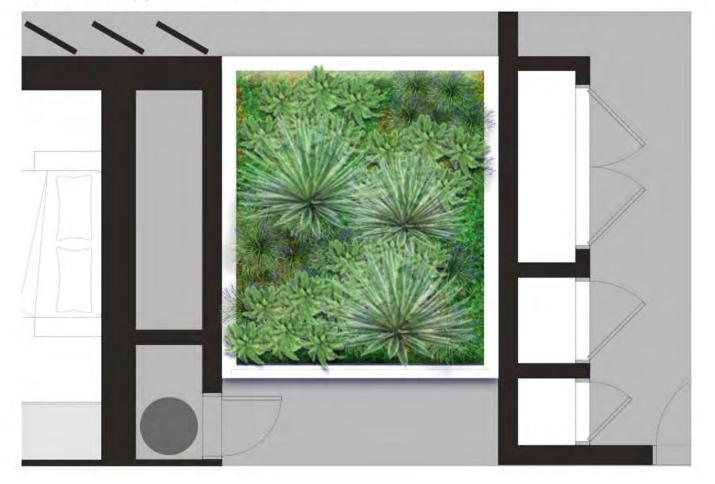

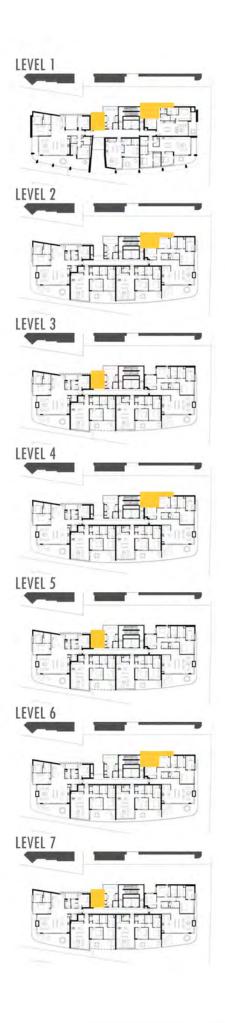


LO8 LANDSCAPE PLAN - ROOFTOP TERRACE

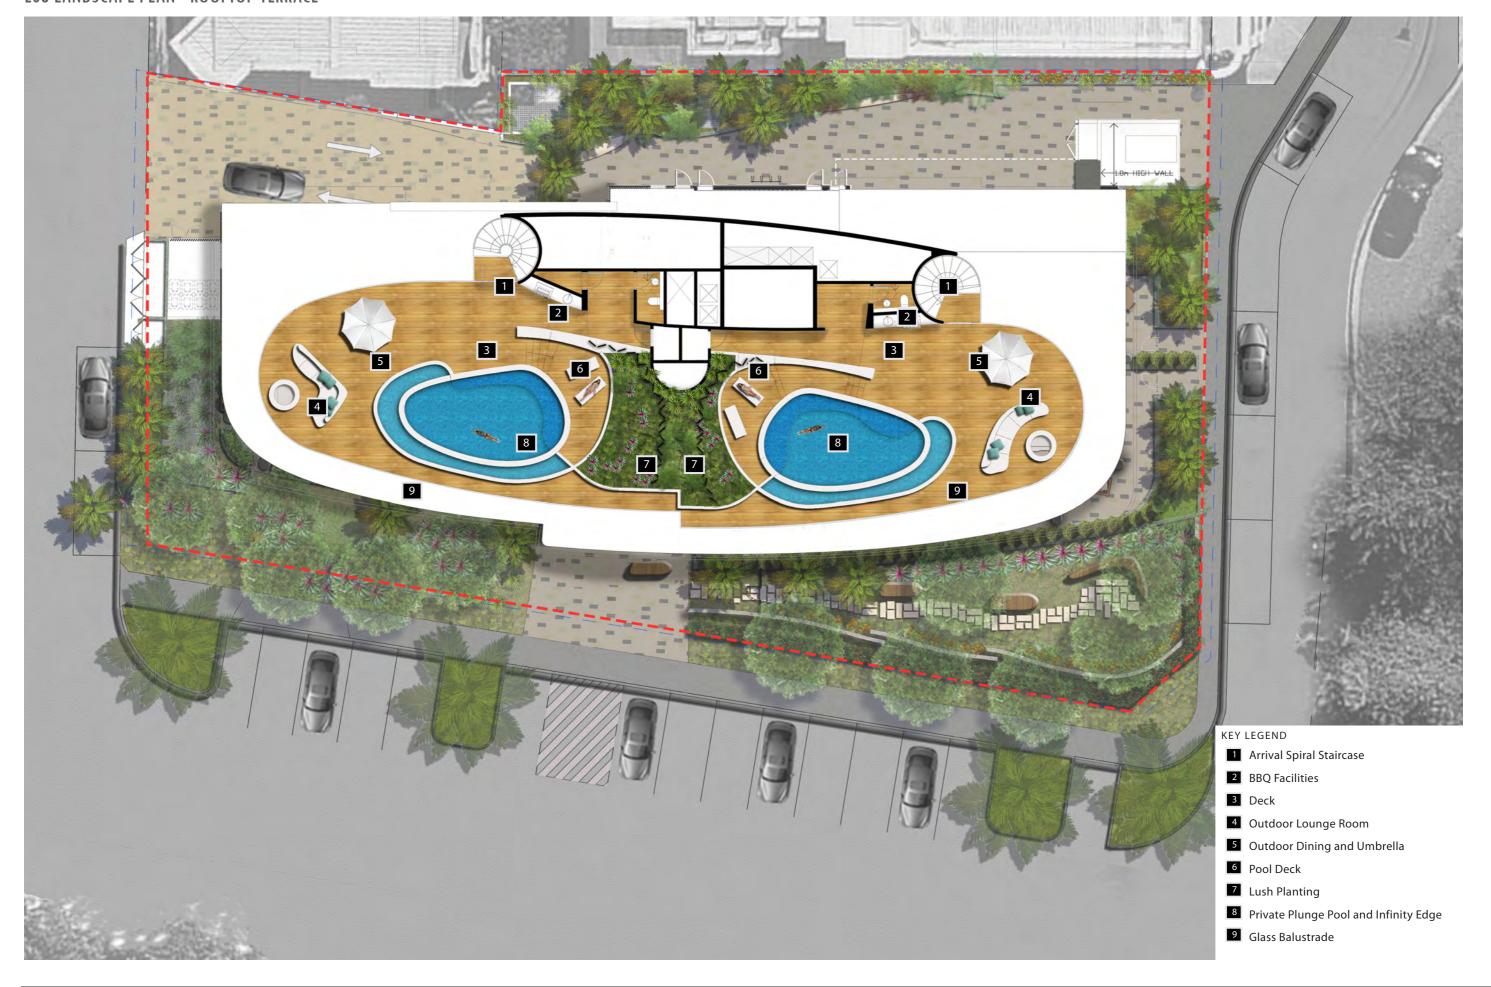




LO9 LANDSCAPE SECTIONS

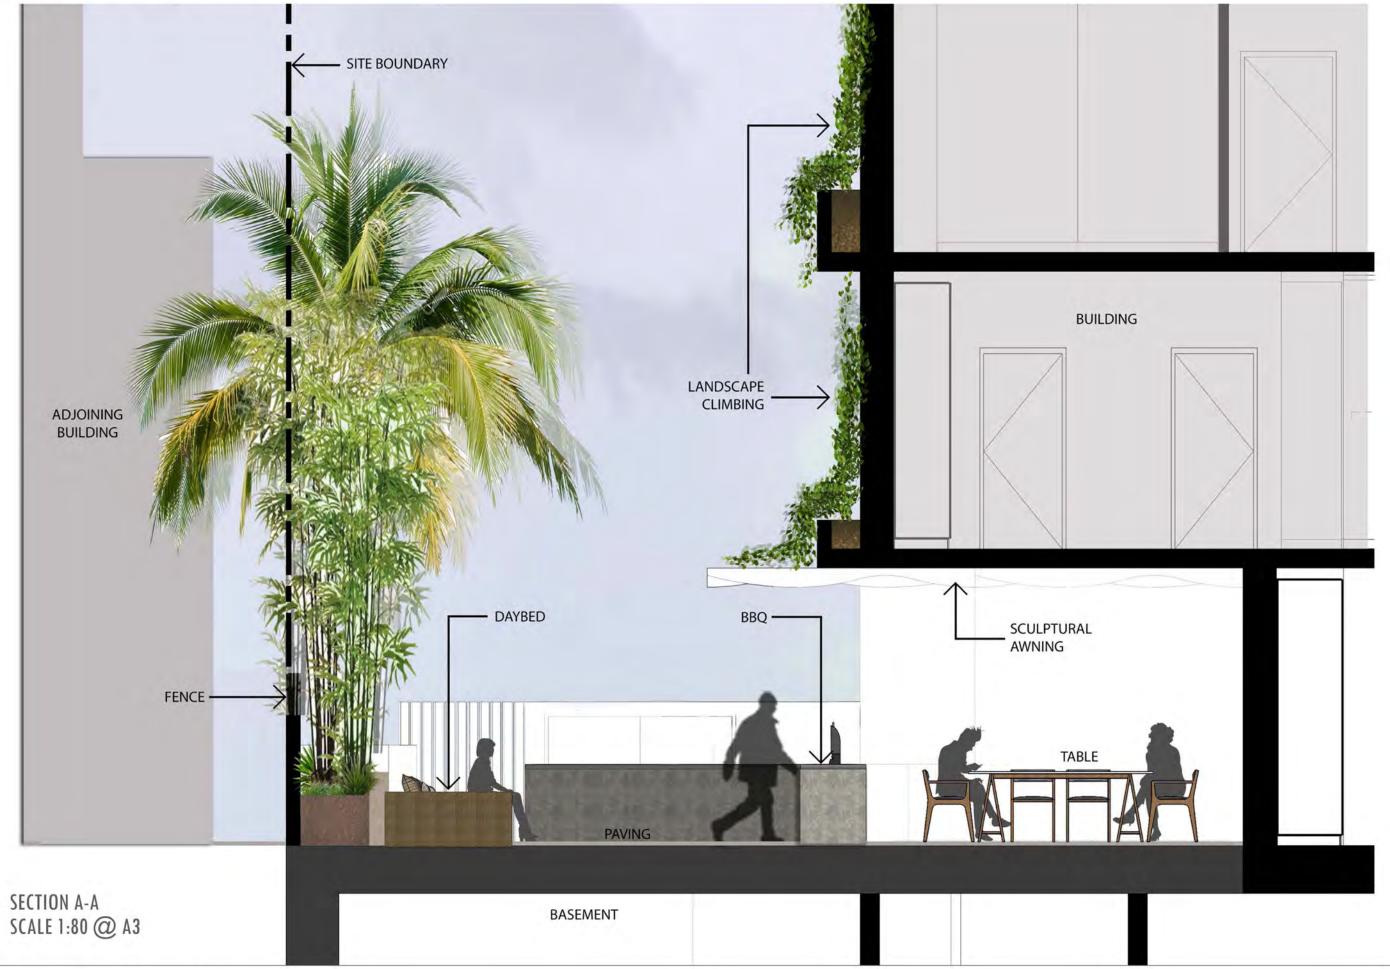



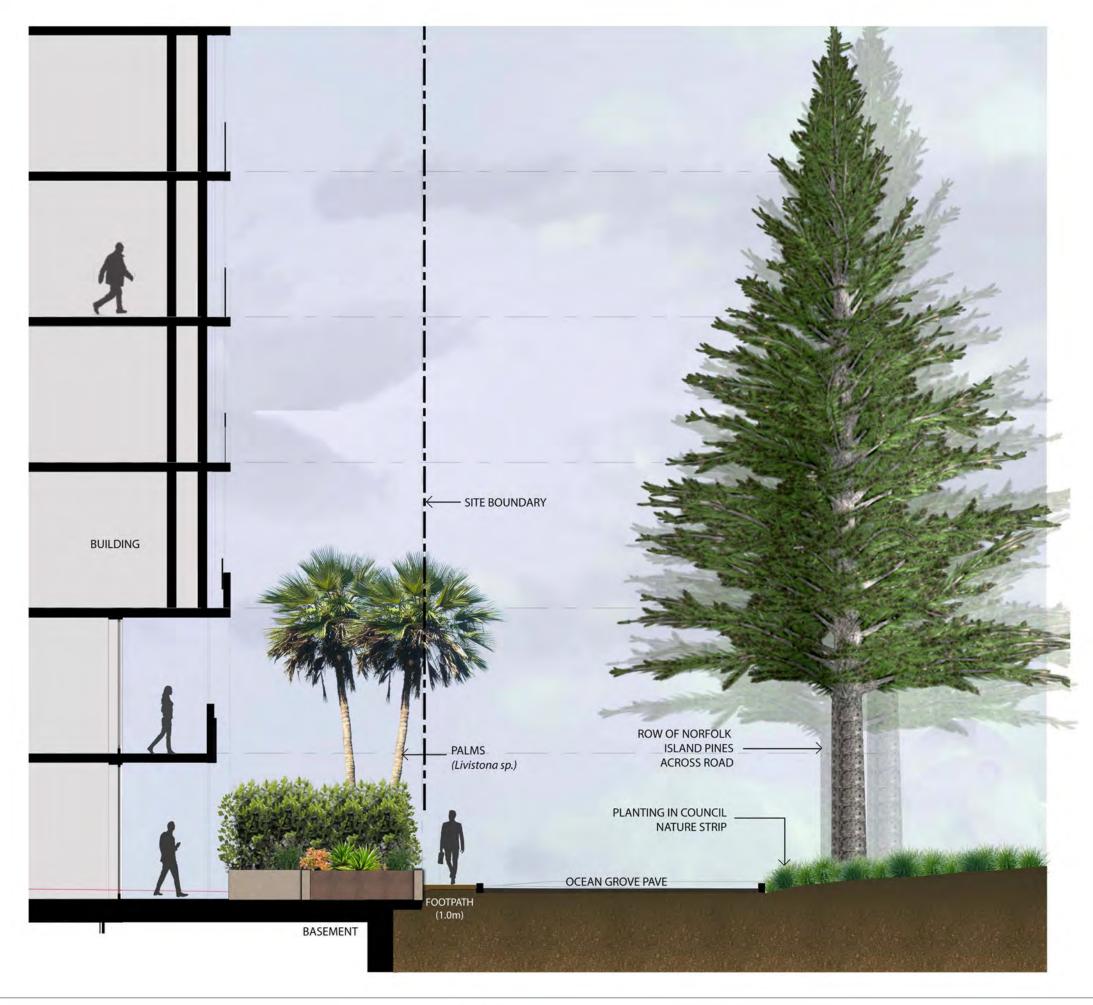

SECTION B-B SCALE 1:200 @ A3



L11 LANDSCAPE SECTIONS



SECTION C-C SCALE 1:50 @ A3 KEY LEGEND

Existing traffic island + palm to be retained

Footpath along kerb subject to council approval

3 Cupianopsis sp. (Tuckeroo) similar to Ozone street tree planting

4 1200mm ht stone wall

5 Native screen planting

6 Low groundcovers (walkable)

7 Stepping stones


8 Timber seats

9 Tuckeroo planting

10 Native screen shrubs

11 Screen shrubs and planter box

12 Palm planting

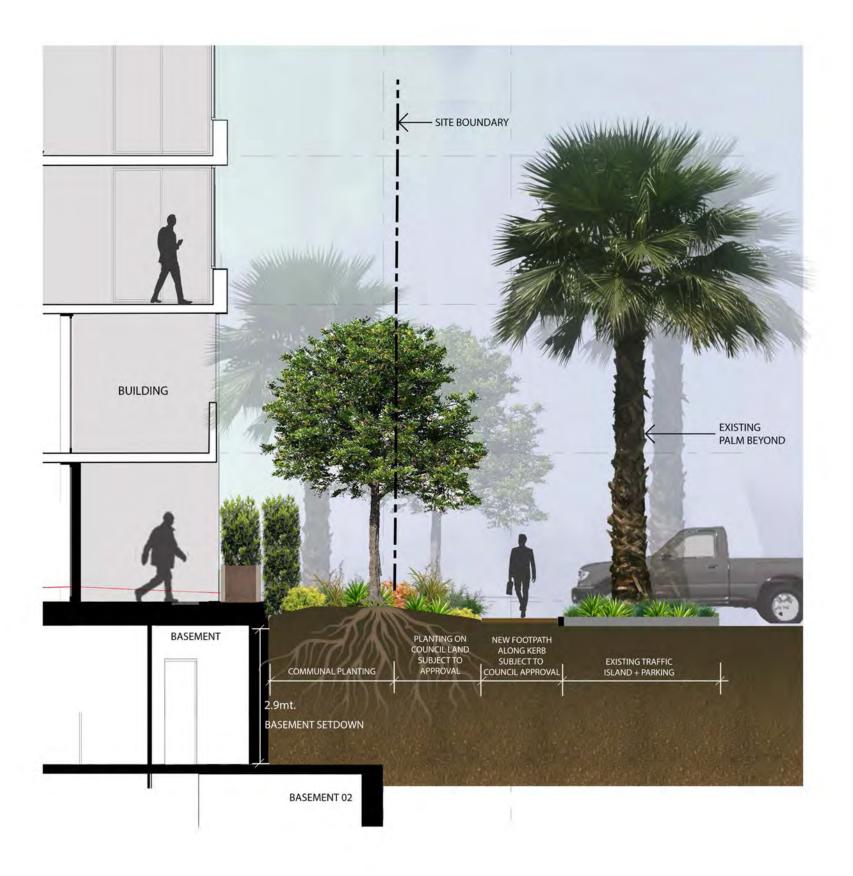

SECTION D-D SCALE 1:50 @ A3



06 PLANTING PALETTE

PLANT SCHEDULE TREES + PALMS

Archontophoenix cunninghamiana Bangalow Palm Livistona australis Cabbage-tree palm Strelitzia nicolai Giant white bird of paradise

Cyathea cooperi Tree fern Cupaniopsis anacardioides Tuckeroo Dracaena draco Dragon Tree Magnolia grandiflora - little gem Dwarf magnolia Waterhousea floribunda Weeping lily pily Bambusa dolichomerithalla 'Silverstripe' Bamboo Plumeria rubra Frangipani

Kentia Palm

SHRUBS

Howea forsteriana

Acmena smithii minor Dwarf lily pily Box hedge Buxus microcarpa japonica Philodendron xanadu Dwarf philodendron Cordyline fruticosa rubra Red cordyline Agave attenuata Agave Yucca elephantipes Yucca Viburnum odoratissimum Sweet viburnum

Dwarf NZ xmas bush Metrosideros fiji fire Grevillea robyn gordon Grevillea

Dwarf bottle brush Callistemon white anzac Syzygium australe southern form Dwarf brush cherry

Doryanthes excelsa Gymea Lily Strelitzia reginae Bird of paradise Mexican lily Beschorneria yuccoides Bromeliad spp Bromeliad Metrosideroa thomasii NZ Christmas bush

GROUND COVERS

Trachelospermum jasminoides Star jasmine Liriope evergreen giant Giant liriope Clivia miniata Kaffır lily Pigface Carpobrotus glaucescens Phormium bronze baby Dwarf flax Convolvulus sabatius Morning glory Viola hederacea Native violet Dichondra silver falls Silver falls

Lomandra tanika Tanika

Hardenbergia violacea False sarsaparilla, Purple coral pea

Myoporum parvifolium Creeping myoporum Grevillea royal mantle Grevillea royal mantle

DESIGN PRECEDENT IMAGES















PROPOSED RESIDENTIAL TOWERS 5-9 OZONE STREET, CRONULLA, NSW CIVIL ENGINEERING WORKS

GENERAL NOTES:

- 1. ALL WORK TO BE CARRIED OUT IN ACCORDANCE WITH SUTHERLAND SHIRE COUNCIL SPECIFICATION. CONTRACTOR TO OBTAIN AND RETAIN A COPY ON SITE DURING THE COURSE OF THE WORKS.
- 2. ALL NEW WORKS ARE TO MAKE A SMOOTH JUNCTION WITH EXISTING CONDITIONS, AND MARRY IN A 'WORKMANLIKE'
- SERVICES SHOWN ON THESE PLANS ARE ONLY THOSE EVIDENT AT THE TIME OF SURVEY OR AS DETERMINED FROM SERVICE DIAGRAMS. HENRY AND HYMAS CONSULTING PTY. LTD. CANNOT GUARANTEE THE INFORMATION SHOWN NOR ACCEPT ANY RESPONSIBILITY FOR INACCURACIES OR INCOMPLETE DATA.
- 4. SERVICES & ACCESSES TO THE EXISTING PROPERTIES ARE TO BE MAINTAINED IN WORKING ORDER AT ALL TIMES DURING
- ADJUST EXISTING SERVICE COVERS TO SUIT NEW FINISHED LEVELS TO RELEVANT AUTHORITY REQUIREMENTS WHERE
- 6. REINSTATE AND STABILISE ALL DISTURBED LANDSCAPED AREAS.
- 7. MINIMUM GRADE OF SUBSOIL SHALL BE 0.5% (1:200) FALL TO OUTLETS.
- 8. ALL TEMPORARY SEDIMENT AND EROSION CONTROL DEVICES ARE TO BE CONSTRUCTED, PLACED AND MAINTAINED IN ACCORDANCE WITH THE TECHNICAL SPECIFICATIONS, EROSION AND SEDIMENTATION CONTROL PLAN AND SUTHERLAND SHIRE COUNCIL REQUIREMENTS WHERE APPLICABLE.
- 9. CONTRACTOR TO CHECK AND CONFIRM SITE DRAINAGE CONNECTIONS ACROSS THE VERGE PRIOR TO COMMENCEMENT
- 10. PROPERTIES AFFECTED BY THE WORKS ARE TO BE NOTIFIED IN ADVANCE WHERE DISRUPTION TO EXISTING ACCESS IS

SITEWORKS NOTES

- DATUM : A.H.D.
- ORIGIN OF LEVELS: REFER TO BENCH OR STATE SURVEY MARKS WHERE
- CONTRACTOR MUST VERIFY ALL DIMENSIONS AND EXISTING LEVELS ON SITE PRIOR TO THE COMMENCEMENT OF WORK.
- ALL WORKS TO BE UNDERTAKEN IN ACCORDANCE WITH THE DETAILS SHOWN ON THE DRAWINGS & THE DIRECTIONS OF THE SUPERINTENDENT.
- EXISTING SERVICES UNLESS SHOWN ON THE SURVEY PLAN HAVE BEEN PLOTTED FROM SERVICES SEARCH PLANS AND AS SUCH THEIR ACCURACY CANNOT BE GUARANTEED. IT IS THE RESPONSIBILITY OF THE CONTRACTOR TO ESTABLISH THE LOCATION AND LEVEL OF ALL EXISTING SERVICES PRIOR TO THE COMMENCEMENT OF ANY WORK. ANY DISCREPANCIES SHALL BE REPORTED TO THE SUPERINTENDENT. CLEARANCES SHALL BE OBTAINED FROM THE RELEVANT SERVICE AUTHORITY.
- WHERE NEW WORKS ABUT EXISTING THE CONTRACTOR SHALL ENSURE THAT A SMOOTH EVEN PROFILE, FREE FROM ABRUPT CHANGES IS ACHIEVED.
- THE CONTRACTOR SHALL ARRANGE ALL SURVEY SETOUT TO BE CARRIED OUT BY A REGISTERED SURVEYOR.
- CARE IS TO BE TAKEN WHEN EXCAVATING NEAR EXISTING SERVICES. NO MECHANICAL EXCAVATION IS TO BE UNDERTAKEN OVER TELSTRA OR
- CONTRACTOR TO OBTAIN AUTHORITY APPROVALS WHERE APPLICABLE.

ELECTRICAL SERVICES. HAND EXCAVATE IN THESE AREAS.

- MAKE SMOOTH TRANSITION TO EXISTING SURFACES AND MAKE GOOD.
- THESE PLANS SHALL BE READ IN CONJUNCTION WITH APPROVED LANDSCAPE, ARCHITECTURAL, STRUCTURAL, HYDRAULIC AND MECHANICAL DRAWINGS AND
- OR WRITTEN INSTRUCTIONS THAT MAY BE ISSUED RELATING TO DEVELOPMENT AT THE SITE.
- TRENCHES THROUGH EXISTING ROAD AND CONCRETE PAVEMENTS SHALL BE SAWCUT TO FULL DEPTH OF CONCRETE AND A MINIMUM OF 50mm IN BITUMINOUS PAVING.
- ALL BRANCH GAS AND WATER SERVICES UNDER DRIVEWAYS AND BRICK PAVING SHALL BE LOCATED IN Ø80 uPVC SEWER GRADE CONDUITS EXTENDING A MINIMUM OF 500mm BEYOND EDGE OF PAVING.
- GRADES TO PAVEMENTS TO BE AS IMPLIED BY RL'S ON PLAN . GRADE EVENLY BETWEEN NOMINATED RL'S. AREAS EXHIBITING PONDING GREATER THAN 5mm DEPTH WILL NOT BE ACCEPTED UNLESS IN A DESIGNATED SAG POINT.
- ALL COVERS AND GRATES ETC TO EXISTING SERVICE UTILITIES ARE TO BE ADJUSTED TO SUIT NEW FINISHED SURFACE LEVELS WHERE APPLICABLE.





LOCALITY SKETCH

	DRAWING SCHEDULE
17A09_DA_C000	COVER SHEET, DRAWING SCHEDULE, NOTES & LOCALITY SKETCH
17A09_DA_C100	STORMWATER MANAGEMENT PLAN
17A09 DA C200	OSD TANK SECTIONS AND DETAILS

DRAINAGE NOTES:

2. CONTRACTOR SHALL BE RESPONSIBLE FOR MAINTAINING THE MINIMUM COVER OF 600mm ON ALL PIPES.

3. PROTECTION OF PIPES DUE TO LOADS EXCEEDING W7 WHEEL LOAD SHALL BE THE CONTRACTOR'S

4. BEDDING TYPE SHALL BE TYPE H2 FOR RCP. WHERE NECESSARY THE OVERLAY ZONE SHALL BE REDUCED TO ACCOMMODATE PAVEMENT REQUIREMENTS, REFER TO THIS DRAWING FOR DETAILS.

MINIMUM COVER OVER EXISTING PIPES FOR PROTECTION DURING CONSTRUCTION SHALL BE 800mm

NO CONSTRUCTION LOADS SHALL BE APPLIED TO PLASTIC PIPES.

7. FINISHED SURFACE LEVELS SHOWN ON LAYOUT PLAN DRGS TAKE PRECEDENCE OVER DESIGN DRAINAGE

8. ALL PIPES UP TO AND INCLUDING 300 DIA. SHALL BE SOLVENT OR RUBBER RING JOINTED PVC CLASS SH PIPE TO AS1260. ALL OTHER PIPES TO BE RCP USING CLASS 2 RUBBER RING JOINTED PIPE. HARDIES FRC PIPE MAY BE USED IN LIEU OF RCP IF DESIRED IN GROUND. ALL AERIAL PIPES TO BE PVC CLASS SH.

9. ALL PITS IN NON TRAFFICABLE AREAS TO BE PREFABRICATED POLYESTER CONCRETE "POLYCRETE" WITH "LIGHT DUTY" CLASS B GALV. MILD STEEL GRATING AND FRAME.

ALL PITS IN TRAFFICABLE AREAS (CLASS "D" LOADING MAX) TO HAVE 150mm THICK CONCRETE WALLS AND BASE CAST IN-SITU fc=32 MPa, REINFORCED WITH N12-200 BOTH LOADING WAYS CENTRALLY PLACE .U.N.O. ON SEPARATE DESIGN DRAWINGS IN THIS SET. GALV.MILD STEEL GRATING AND FRAME TO SUIT DESIGN LOADING. PRECAST PITS, RECTANGULAR OR CIRCULAR IN SHAPE. MAY BE USED IN LIEU AND SHALL COMPLY WITH RELEVANT AUSTRALIAN

10. ALL PITS, GRATINGS AND FRAMES SHALL BE INSTALLED IN ACCORDANCE WITH THE MANUFACTURERS SPECIFICATION AND TO BE IN ACCORDANCE WITH AS3500.3 AND AS3996.

11. PIT CHAMBER DIMENSIONS ARE TO BE SELECTED TO SATISFY THE FOLLOWING:

- DEPTH TO INVERT

- SKEW ANGLE

REFER TYPICAL PIT CHAMBER DETAILS BELOW

IF PIT LID SIZE IS SMALLER THAN THE PIT CHAMBER SIZE THEN THE PIT LID IS TO BE CONSTRUCTED ON THE CORNER OF THE PIT CHAMBER WITH THE STEP IRONS DIRECTLY BELOW. ALTERNATIVELY THE PIT LID TO BE USED, IS TO BE THE SAME SIZE AS THE PIT CHAMBER

12. FOR PIPE SIZES GREATER THAN Ø300mm, PIT FLOOR IS TO BE BENCHED TO FACILITATE FLOW.

13. GALVANISED STEP IRONS SHALL BE PROVIDED AT 300 CTS FOR PITS HAVING A DEPTH EXCEEDING 1200mm. SUBSOIL DRAINAGE PIPE SHALL BE PROVIDED IN PIPE TRENCHES ADJACENT TO INLET PIPES. (MINIMUM LENGTH 3m)

14. ALL SUBSOIL PIPES SHALL BE 100mm SLOTTED PVC IN A FILTER SOCK, UNO, WITH 3m INSTALLED UPSTREAM OF

15. ALL PIPEWORK SHALL HAVE MINIMUM DIAMETER 100

16. MINIMUM GRADE FOR ROOFWATER DRAINAGE LINES SHALL BE 1%

17. ALL PIPE JUNCTIONS AND TAPER UP TO AND INCLUDING 300 DIA. SHALL BE VIA PURPOSE MADE FITTINGS.

18. ALL ROOF DRAINAGE TO BE INSTALLED IN ACCORDANCE WITH AS3500, PART 3. TESTING TO BE UNDERTAKEN AND REPORTS PROVIDED TO THE SUPERINTENDENT.

19. LOCATION OF THE DIRECT DOWN PIPE CONNECTIONS MAY VARY ON SITE TO SUIT SITE CONDITIONS, WHERE CONNECTION SHOWN ON LONG SECTIONS CHAINAGES ARE INDICATIVE ONLY.

20. PITS IN EXCESS OF 1.5 m DEEP TO HAVE WALL AND FLOOR THICKNESS INCREASED TO 200mm. REINFORCED WITH N12@200 CTS CENTRALLY PLACED BOTH WAYS THROUGHOUT U.N.O.ON SEPARATE DESIGN DRAWINGS IN THIS SET. IF DEPTH EXCEEDS 5m CONTACT ENGINEER.

21. SUBSOIL DRAINAGE LINES FOR LANDSCAPE AREA NOT SHOWN ON THESE DRAWINGS. REFER TO LANDSCAPING

22. ALL STORMWATER PITS TO HAVE Ø100 uPVC SLOTTED SUBSOIL PIPES CONNECTED TO THEM. THESE SUBSOILS TO EXTEND 3m UPSTREAM OF THE PIT AT A MINIMUM GRADE.

SURVEY NOTES

THE EXISTING SITE CONDITIONS SHOWN ON THE FOLLOWING DRAWINGS HAVE BEEN INVESTIGATED BY THE SURVEYOR SPECIFIED IN THE TITLE

THE INFORMATION IS SHOWN TO PROVIDE A BASIS FOR DESIGN. HENRY AND HYMAS PTY. LTD. DOES NOT GUARANTEE THE ACCURACY OR COMPLETENESS OF THE SURVEY BASE OR ITS SUITABILITY AS A BASIS FOR CONSTRUCTION DRAWINGS.

SHOULD DISCREPANCIES BE ENCOUNTERED DURING CONSTRUCTION BETWEEN THE SURVEY DATA AND ACTUAL FIELD DATA, CONTACT HENRY AND HYMAS PTY. LTD. THE FOLLOWING NOTES HAVE BEEN TAKEN DIRECTLY FROM ORIGINAL SURVEY DOCUMENTS.

ORIGIN OF LEVELS DATUM CONTOUR INTERVAL

FOR DA ONLY

M.Stimova I.Ahmed JULY 2018 PROPOSED RESIDENTIAL TOWER REBEL PROPERTY GROUP LEDA HOLDINGS SURVEY +61 2 9417 8400 79 Victoria Avenue Chatswood NSW 2067 Facsimile **INFORMATION** 6-9 OZONE ST. CRONULLA, NSW +61 2 9417 8337 A.Francis A.Francis NTS @ A1 SURVEYED BY: LTS LOCKLEY email@hhconsult.com.au vic lake architecture + interior design ORIGIN OF LEVELS: SSM 125908 COVER SHEET, DRAWING SCHEDULE, www.henryandhymas.com.au RL.14.912 (AHD) IN SURF LANE 01 ISSUED FOR DEVELOPMENT APPLICATION MS IA 31.07.2018 This drawing and design remains the property of Henry & Hymas and may not be **NOTES & LOCALITY SKETCH** CONTOUR INTERVAL 0.5m
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